

Application for Architectural Review Board

* This application must be filled out completely and signed before submittals are placed on the ARB agenda.

The purpose of Architectural Review Board shall be to two-fold; to develop architectural and design guidelines for the City of Ladue in accordance with section 110-70 and to apply those guidelines in reviewing projects within the City as to whether or not the project adheres to such guidelines.

APPLICANT INFORMATION
Name of Applicant: Daniel Fort
Phone #: (314) 288 - 911 8
Email address of Applicant (for review comments): DFORT @ HERM COS. COM
PROJECT PROPERTY INFORMATION
Address for proposed work: 9747 LITZINGERD
Address for proposed work: 9747 LITZSINGER D Zoning District: RES. B Parcel ID # (St. Louis county record): 29L110094
DESCRIPTION OF PROPOSED PROJECT: NEW 13.9' × 19.3' BREEZEWAY
Additional Information:
 Professionally sealed plans are not required for ARB review. Plans for projects involving alterations and repairs, which do not affect the outward appearance of a buildin and existing decks, fences, window replacements and roofing shingle replacements shall not require approv of the Architectural Review Board. Revised plans with any changes predicated by the ARB will need to be submitted with the building permapplication to the Department of Planning and Development with final trustee approval (if applicable.) Projects approved by ARB should be submitted for building permits within 180 days or the ARB approval mathematical become void.
By signing this application, you acknowledge that by submitting an incomplete application, your petition will no be added to the meeting agenda.
X Date:
* This application and review for City of Ladue building permitted purposes only. Please be aware of any addition


covenants and indentures which may be recorded with your subdivision.









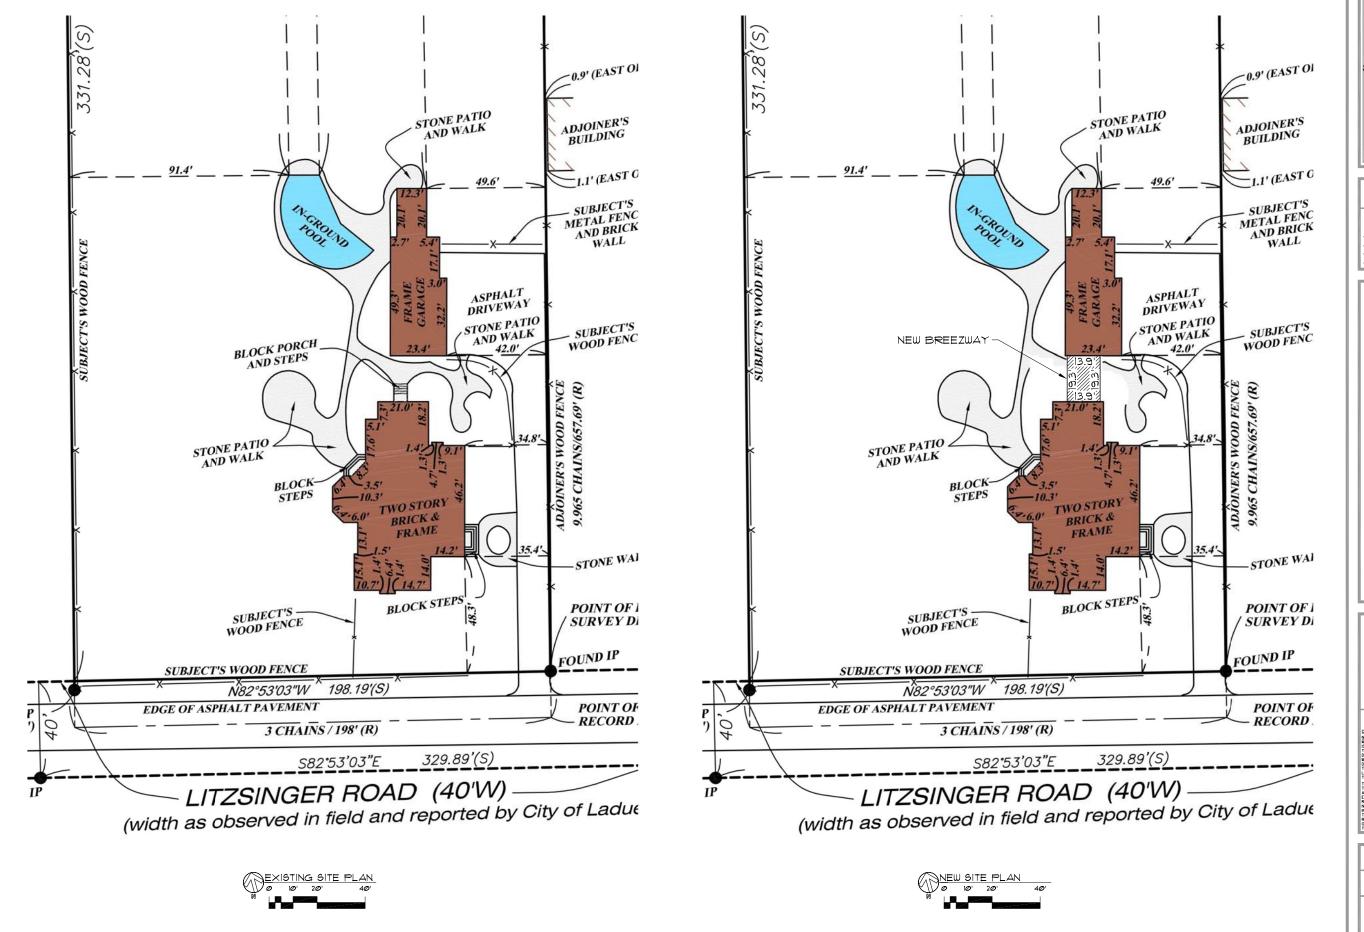

September 10, 2020

A REVISION (DATE-BY):

for:

9747 Litzsinger Rd., Ladue St. Louis County, MO 63124 Daniel Fort Residentia


Michael E. Blaes - Architect MO # A-6158 CERTIFICATE OF AUTHORITY #2016000407

Drawn By:

Checked By: As Noted


Drawing Name: Site Plan


Sheet No.

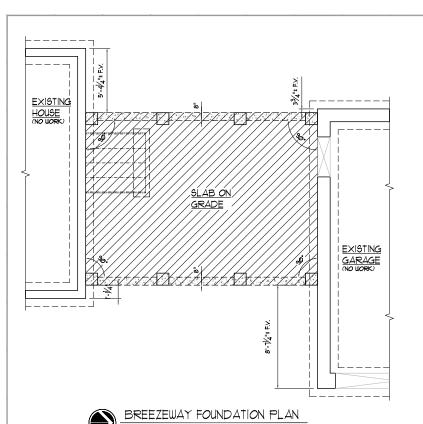



- 1) POINT OF ORIGIN
- (3) DOWEL TO EXIST. FOUNDATION *4's (MIN 24") *8 8"
 O.C. MIN. 6" EMBED LAP DOWEL TO VERTICAL
 REBAR PROVIDE BENTONITE WATERSTOP ROPE VERTICALLY & CENTER OF NEW FORMS WHERE OLD FDN. MEETS NEW, WATERPROOF OUTSIDE SEAM W/RUBBER-WALL, MIN. 12" EACH SIDE OF SEAM - SEE
- 4" TK. CONCRETE SLAB W/ 6%6 WIAXWIA WUF OVER IØ MIL VAPOR BARRIER & 4" COMPACTED GRANULAR FILL PROVIDE CRACK CONTROL JOINTS & 10"-0" MAX OC. EA, WAY, TOOLED CONTROL JOINTS (OUNER SELECTED STAMPED & 474 AND ENIONE)
- 5) THICKENED SLAB SEE DETAIL
- 6 FLOOR DRAIN SLOPE FLOOR 1/8"/FT. TO DRAIN -VERIFY LOCATION W/ OWNER
- (1) EXISTING CONCRETE FOUNDATION WALL NO WORK
- 8) PROFILE OF STRUCTURE ABOVE

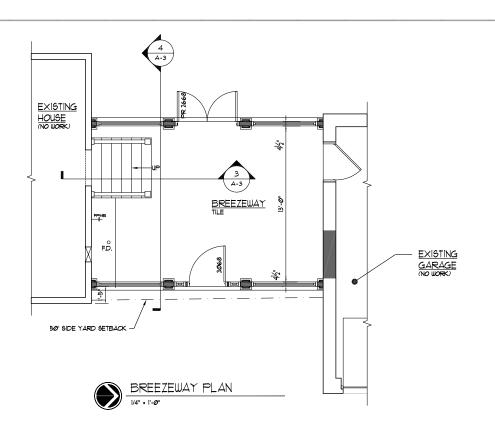

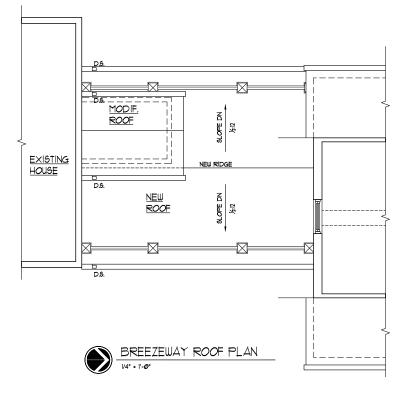

FIRST FLOOR KEYED NOTES:

- () 8" 9QUARE LOAD BEARING PERMACAST COLUMNS W/ RECESSED PANEL, CAP 4 BASE BY HB4G OR APPROVED EQUAL SEE SECTION
- $\fbox{2}$ PROFILE OF MIN 2-2x10 BOX BEAM ABOVE SEE SECTION
- (3) 4" TK. CONCRETE SLAB W/ 6x6 WI.4xWI.4 WUF OVER IØ MIL VAPOR BARRIER 4 4" COMPACTED GRANULAR FILL PROVIDE CRACK CONTROL JOINTS 6 W-6" MAX O.C. EA. WAY, TOOLED CONTROL JOINTS (OWNER SELECTED STAMPED 4 STAINED FINISH)
- 4 1^14 "4 WOOD HANDRAIL 4 STAIR SEE STAIR DETAILS
- (5) OWNER SELECTED 36" HIGH WORKBENCH
- (6) PROVIDE M.R. GYP BD * ALL WALLS & CEILING FULL HEIGHT
- (1) 8" SQUARE LOAD BEARING PERMACAST COLUMN W/ CAP & BASE BY HB4G OR APPROVED EQUAL
- 8 PROFILE OF BOX BEAM ABOVE SEE PORCH SECTION

FLOOR PLAN NOTES:

ALL EXTERIOR WALLS 2x4 WOOD STUDS * 16" O.C. W/ $\frac{1}{2}$ " WOOD STRUCTURAL PANELS ONE SIDE $\mathbf{1}_{\frac{1}{2}}^{\mathrm{H}}$ GWB ONE SIDE UNLESS OTHERWISE NOTED

ALL INTERIOR WALLS 2x4 WOOD STUDS 4 16" O.C. W/ 12 " GWB BOTH SIDES WALESS OTHERWISE NOTED

PROVIDE DOUBLE JOISTS UNDER WALLS PARALLEL TO JOIST SPANS

PROVIDE SOLID BLOCKING BENEATH GIRDER TRUSS BEARING POINTS TO FOUNDATION OR STEEL BEAM BELOW

ELECTRICAL CONTRACTOR TO COORDINATE FINAL LOCATION & QUANTITY OF ALL LIGHTS, FANS, RECEPTACLES, SWITCHES AND FLOOR RECEPTACLES WITH THE OWNER PRIOR TO SUBMITTING BID.

MECHANICAL CONTRACTOR TO COORDINATE FINAL LOCATION 4 QUANTITY OF ALL SUPPLY DUCTS 4 SIZE OF ANY PENETRATIONS THRU FIDE WALLS 4 ROUTING OF SUPPLY/RETURN DUCTS PRIOR TO SUBMITTING BID.

THE INTERIOR AND EXTERIOR WALL CONFIGURATION BRACES THE STRUCTURE IN ACCORDANCE WITH OR EQUIVALENT TO THE CONTINUOUS SHEATHING METHOD WITH CORNER FRAMING OF SECTION R602104.1 OF THE 2003 EDITION OF IRC. (ALL EXTERIOR WALLS TO BE CONTINUOUSLY SHEATHED WITH !" WOOD STRUCTURAL PANELS)

ROOF PLAN KEYED NOTES:

- (2) 6" ALUMINUM GUTTER & 3x4 D.S. PROVIDE LEAF GUARDS
- 3 CONTINUOUS ALUMINUM FLASHING
- 4 PROFILE OF BOX BEAM BELOW
- (5) 2x RAFTERS @ 24" O.C.
- 6 WOOD GUARDRAIL 4 NEWEL POST SEE SECTION

ddition

for

Date:

September 10, 2020

A REVISION (DATE-BY):

Ladue 63124 Fort Rd., L , MO 47 Litzsinger Ro Louis County, Daniel n tia 9747 St. Lo 0

 ∇

<u>.</u>

Φ

Y

Michael E. Blaes - Architect MO # A-6158 CERTIFICATE OF AUTHORITY #2016000407 CERTIFICATE OF AUTHORITY \$2016000407 NOTICE OF SHAPED PROPERTY MICHAEL E. BLAES, ARCHITECT OF RECORD IS NOT RESPONSIBLE FOR INTERPRETING THE PROPERTY OF THE WORK WHERE CHANGES TO THE WORK WHE


Drawn By:

Checked By:

Drawing Name: Breezeway Plans

Sheet No. A-1

ALL STRUCTURAL 4 FRAMING LUMBER TO BE MIN 41 GRADE SYP OR BETTER

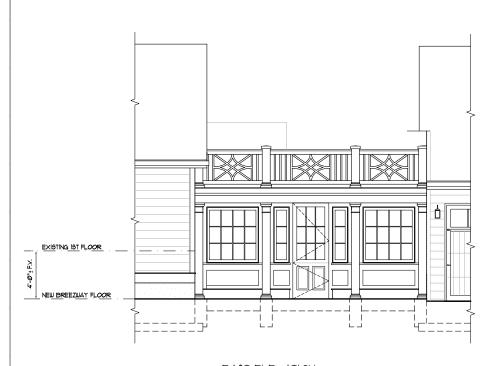

EAST ELEVATION

SCALE: 1/4" = 1'-0"

ELEVATION KEYED NOTES:

1 ROOFING:

MATERIAL:
FULLY ADHERED 60 MIL EPDM ROOF MEMBRANE
ON 3" WOOD STRUCTURAL PANEL
MANUFACTURER: T.B.D.
PRODUCT NAME: T.B.D.
WARRANTY: 25 YEAR MINIMUM
COLOR: BLACK
MISC: HIGH DENSITY RIGID TAPERED INSULATION 1/2 SLOPE - R-49 MIN.

(2) GUTTERS 4 DOWNSPOUTS:
MATERIAL: ALLMINUM
SIZE: 6", 3x4 DOWNSPOUTS W/ BRACKETS
PROFILE: COEE
COLOR: BLACK
MISC: k/3 GUTTER BD. 4 CONTINUOUS ALUMINUM
GUTTER 4 DOWNSPOUT W/ LEAF GUARDS

3 FLASHING:

MATERIAL: CORROSION-RESISTANT METAL FLASHING (ALUM)

ROOF/WALL: CORROSION-RESISTANT METAL FLASHING (ALUM.)

4 SIDING:

MATERIAL: HARDIE STUCCO PANEL
(HARDIPANEL)
TRIM: IX HARDIPLANK TRIM - PAINT
COLOR: WHITE TRIM ON WHITE PANELS
WINDOW TRIM: IX HARDIPLANK - PAINT
SOFFITS: EXPOSED RAFTER TAILS ALUMINUM WRAP
@ ALL FASCIAS
PROVIDE SEALANT & FLASHING AT ALL PANEL &
TRIM JOINTS PER MANUFACTURER SPECIFICATIONS

5 WINDOWS: (SIZES SHOWN IN FT.-IN., NOM. UNIT SIZE)


MANUFACTURER: MARVIN OR EQUAL MATERIAL: CLAD WOOD - MATCH EXISTING GLASS: INSULATED, LOW E MUNTING: SIMULATED DIVIDED LIGHTS - AS SHOUN COLOR: WHITE EXTERIOR, PRE-FINISH WHITE INTERIOR HARDWARE: WHITE - STANDARD SCREENS: CHARCOAL / WHITE FRAMES JAMB THICKNESS: 4 9/16"
WINDOW TRIM: 5½" & FRAME WALLS MAX U-FACTOR: 0.35 PER 2015 IRC TABLE NI02.1 MISC: MANUFACTURER TO FIELD VERIFY SIZES AND LOCATIONS W OWNER PRIOR TO ORDERING. DOUBLE HUNG WINDOW PAIRS TO HAVE SUPPORT MULLION - HEADERS SIZED ACCORDINGLY

6 DOORS: (SIZES SHOWN IN FT.-IN., NOM. UNIT SIZE)
MANUFACTURER: MARVIN OR EQUAL

MANUFACTURER: MARVIN OR EQUAL
MATERIAL: CLAD WOOD UNITS
GLASS: INSULATED, LOW E
MINTINS, SDL, AS SHOWN
COLOR: WHITE
HARDWARE: STANDARD
SCREENS: CHARCOOL / T.B.D. FRAMES
JAMB THICKNESS: 4 9/16"
DOOR TRIM: 5 ½" & FRAME WALLS - WHITE
MISC: MANUFACTURER TO FIELD VERIFY SIZES
AND LOCATIONS W/ OWNER PRIOR TO ORDERING.
MATCH EXISTING INTERIOR DOOR 4 HARDWARE

- 9 APPROXIMATE GRADE LINE
- DEXISTING STRUCTURE TO REMAIN
- (I) 8" SQUARE LOAD BEARING PERMACAST COLUMN W/ RECESSED PANEL AND CAP & BASE BY HB&G OR EQUAL
- 12) BOX BEAM SEE SECTION
- (B) CONCRETE PIER MIN 30" BELOW GRADE SEE DETAIL
- (4) CONTINUOUS CONCRETE FOUNDATION WALL & FOOTING MIN 30" BELOW GRADE
- (B) EXTERIOR WALL MOUNTED LIGHT COORDINATE SELECTION W/ OWNER
- (6) IXIØ HARDIPLANK BAND BOARD W/ FLASHING SEE SECTION
- (1) TERRACE GUARDRAIL SEE SECTION



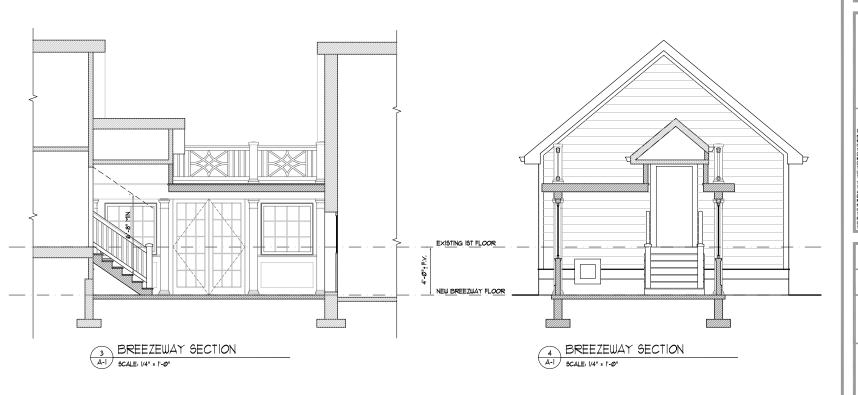



Date:
September 10, 2020

A REVISION (DATE-BY):

Adition for:
Fort
Rd., Ladue

 \triangleleft

ntial

side

Ψ Υ

Daniel Fort 9747 Litzsinger Rd., L St. Louis County, MO (

Michael E. Blaes - Architect
MO # A-6158


CERTIFICATE OF AITHORITY #2016000402


MOICE OF SHARED PROPERTY OF RECORD
MOICE OF SHARED PROPERTY OF RECORD
MOILE SHARED PROPERTY OF RECORD
MOILE SHARED PROPERTY OF THE CONSTRUCTION
DOCUMENTS IN INCLUDING MARKING
HE ACHITECT OF THE CONSTRUCTION PHASE AND
DUBING THE CONSTRUCTION PHASE AND
DUBING THE CONSTRUCTION PHASE AND
DUBING THE CONSTRUCTION PHASE AND
THE SEAL AND SOMUTIVE APPLY ONLY THE
FERD THE SHARED SHARED SHARED
FERSEXY DISCRUMENTS HAVE SEEN MOSE
THE SEAL AND SOMUTIVE APPLY ONLY THE
FERSEXY DISCRUMENTS HAVE SEEN MOSE
THE SEAL AND SOMUTIVE APPLY ONLY THE
FERSEXY DISCRUMENTS HAVE SHARED
FERSEXY DISCRUMENTS HAVE SHARED
FERSEXY DISCRUMENTS HAVE SHARED
FERSEXY DISCRUMENTS HAVE SHARED
THE SHARED
FOR THE SHARED
THE SHARED
FOR THE SHARED
THE SHARED
FOR THE SHARED
THE SHARE

Drawn By: TS Checked By:

Drawing Name: Breezeway Elevations Building Sections

Sheet No.

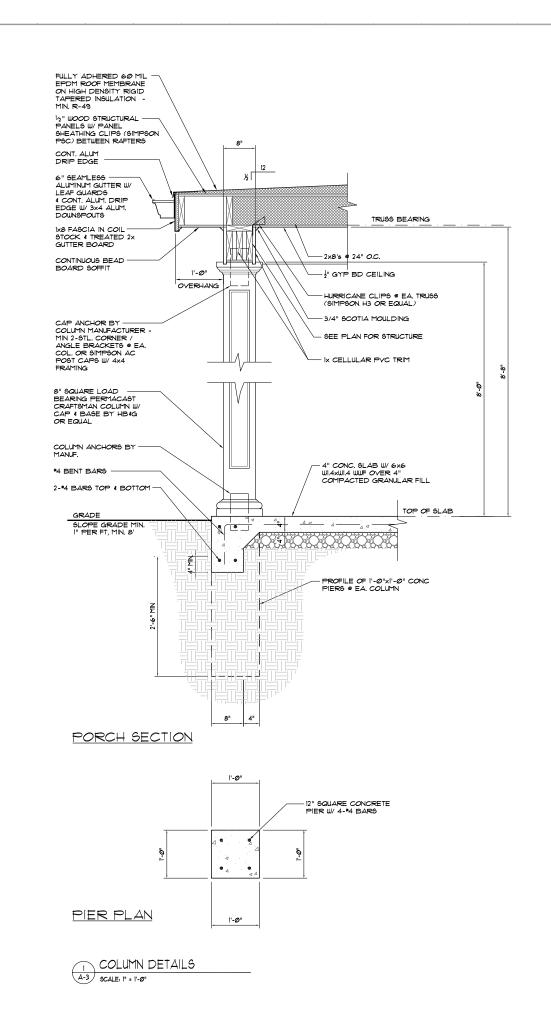

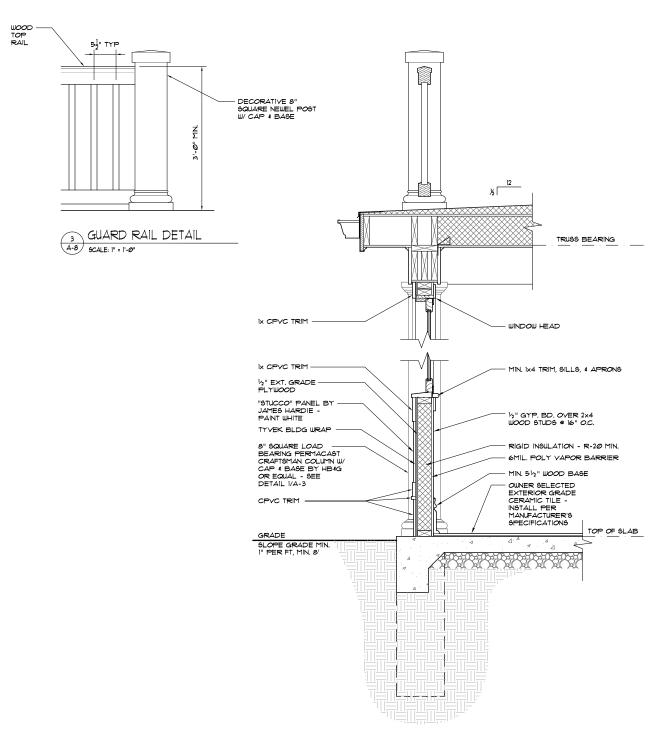

WALL SECTION

2 A-3 SCALE: |" = |'-@"

 \triangleleft ntial sider Φ ľ

Park Station MO 63119 1-9202

Date: September 10, 2020 A REVISION (DATE-BY):

for

ddition

Rd., Ladue y, MO 63124 Daniel Fort 9747 Litzsinger R St. Louis County,

Michael E. Blaes - Architect Michael E. Blaes - Architect MO# A-6156 SECRETICATE OF AUTHORITY 20016000407. WINDLE SECRETICATE OF AUTHORITY AUTHORITY 20016000407. WINDLE SEAS, AND SECRETICATE OF RECORD IS NOT RESPONSIBLE FOR INTERPRETING THE MITTHY OF THE CONSTRUCTION THASE; AND UNDURATION OF MAY BE RECESSARY DURING THE CONSTRUCTION PHASE; AND THE ARCHITECT OF RECORD IS NO LIONGER TO THESE DOCUMENTS HAVE BEEN MADE. THE SEAL AND SIGNATURE APPLY ONLY TO THESE DOCUMENTS HAVE BEEN MADE.

TO THESE DOCUMENTS HAVE BEEN MADE. THE SEAL AND SONATURE ARRY ONLY TO THE DOCUMENT TO WHICH THEY ARE AND SONATURE ARRY OF THE DOCUMENT TO WHICH THEY ARE AND SONATURE TO SONATURE TO SONATURE TO SONATURE TO SONATURE TO TO, DRAWNING, SPECIFICATIONS ESTIMATES OF SONACES INTERCED TO BE USED FOR THE STRUCKETS OF SONACES INTERCED TO BE USED FOR THIS PROJECT.

Drawn By:

Checked By:

Drawing Name: Details

Sheet No.

A-3